

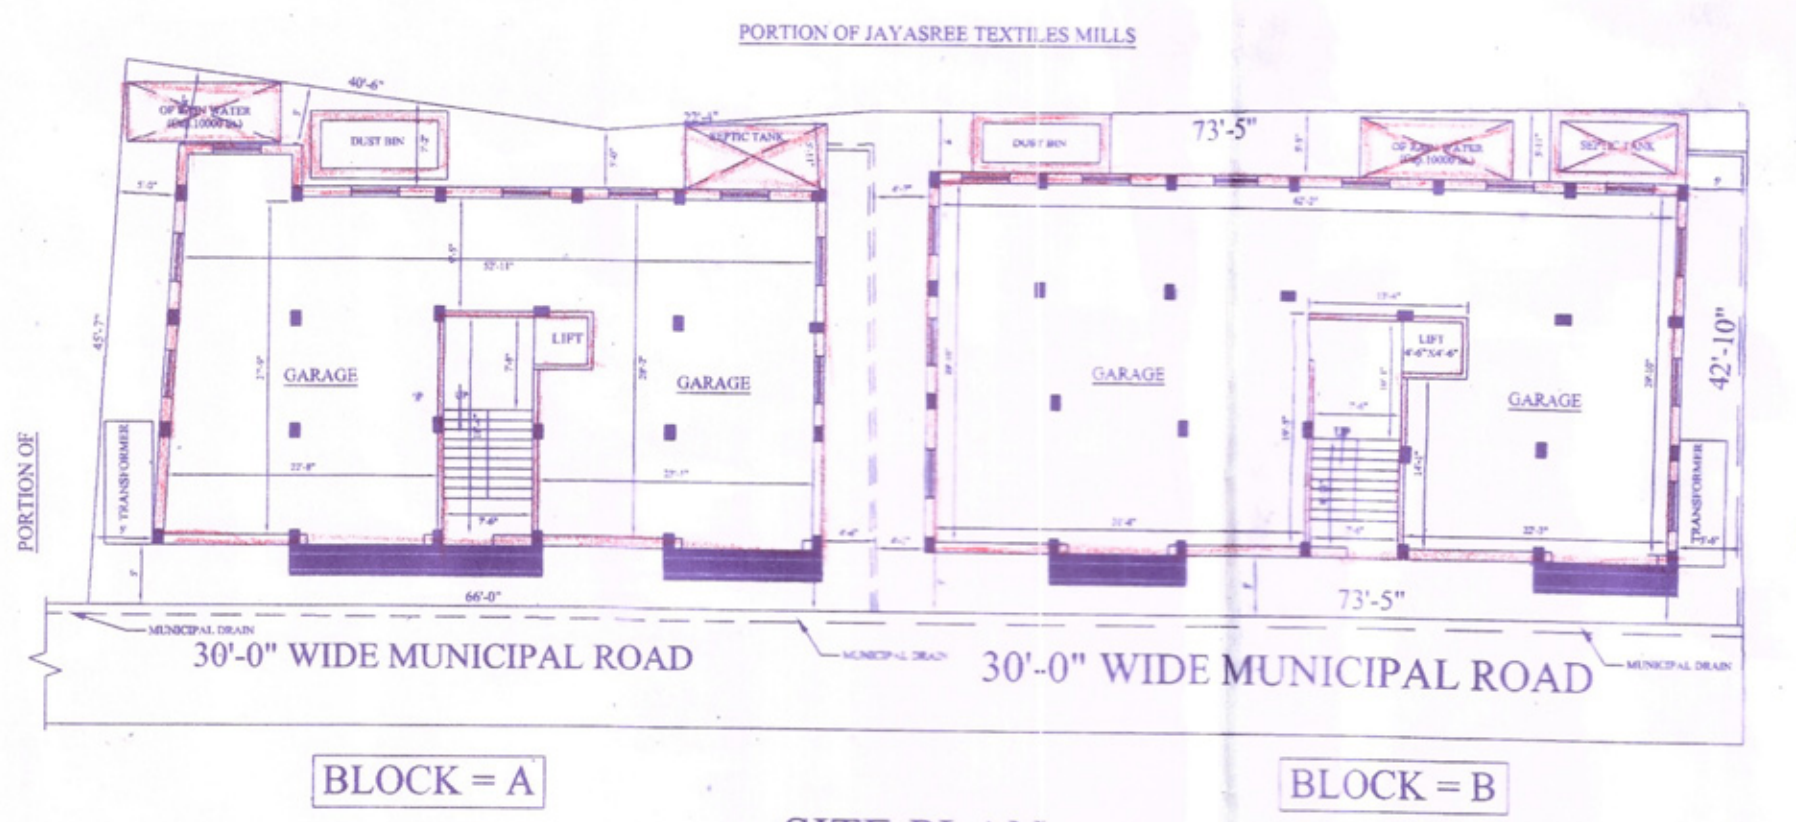
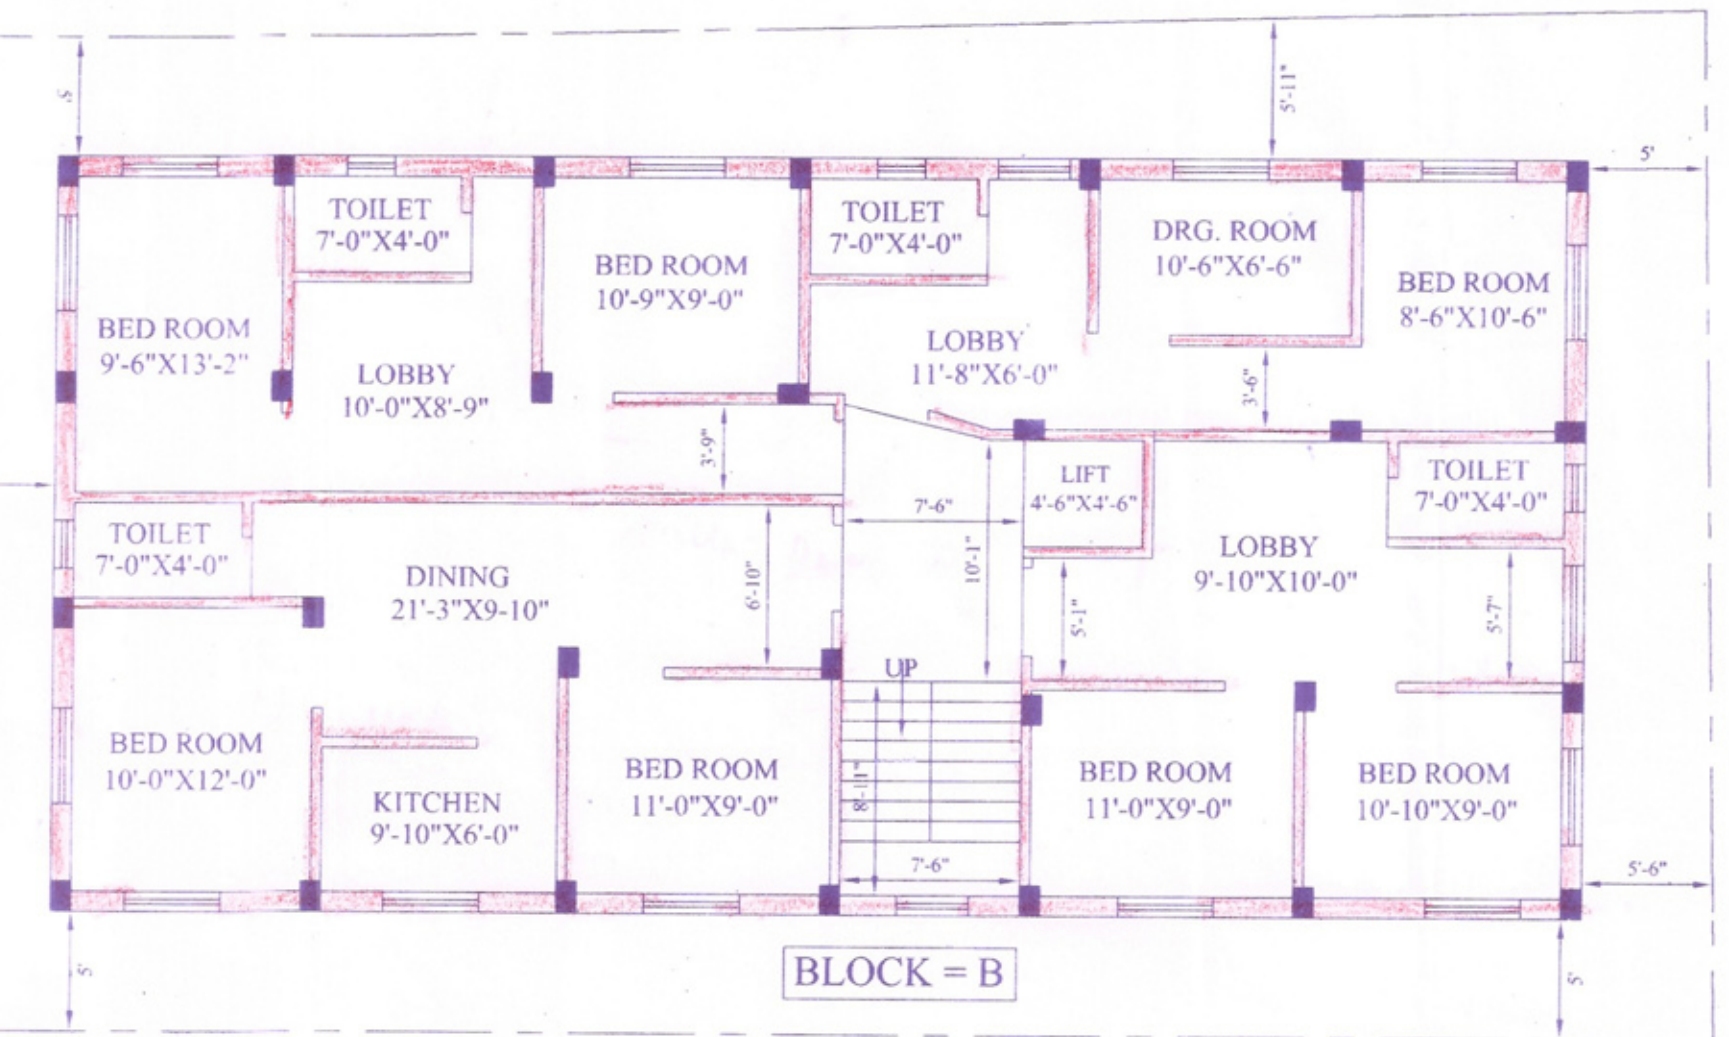



ROOF FLOOR PLAN

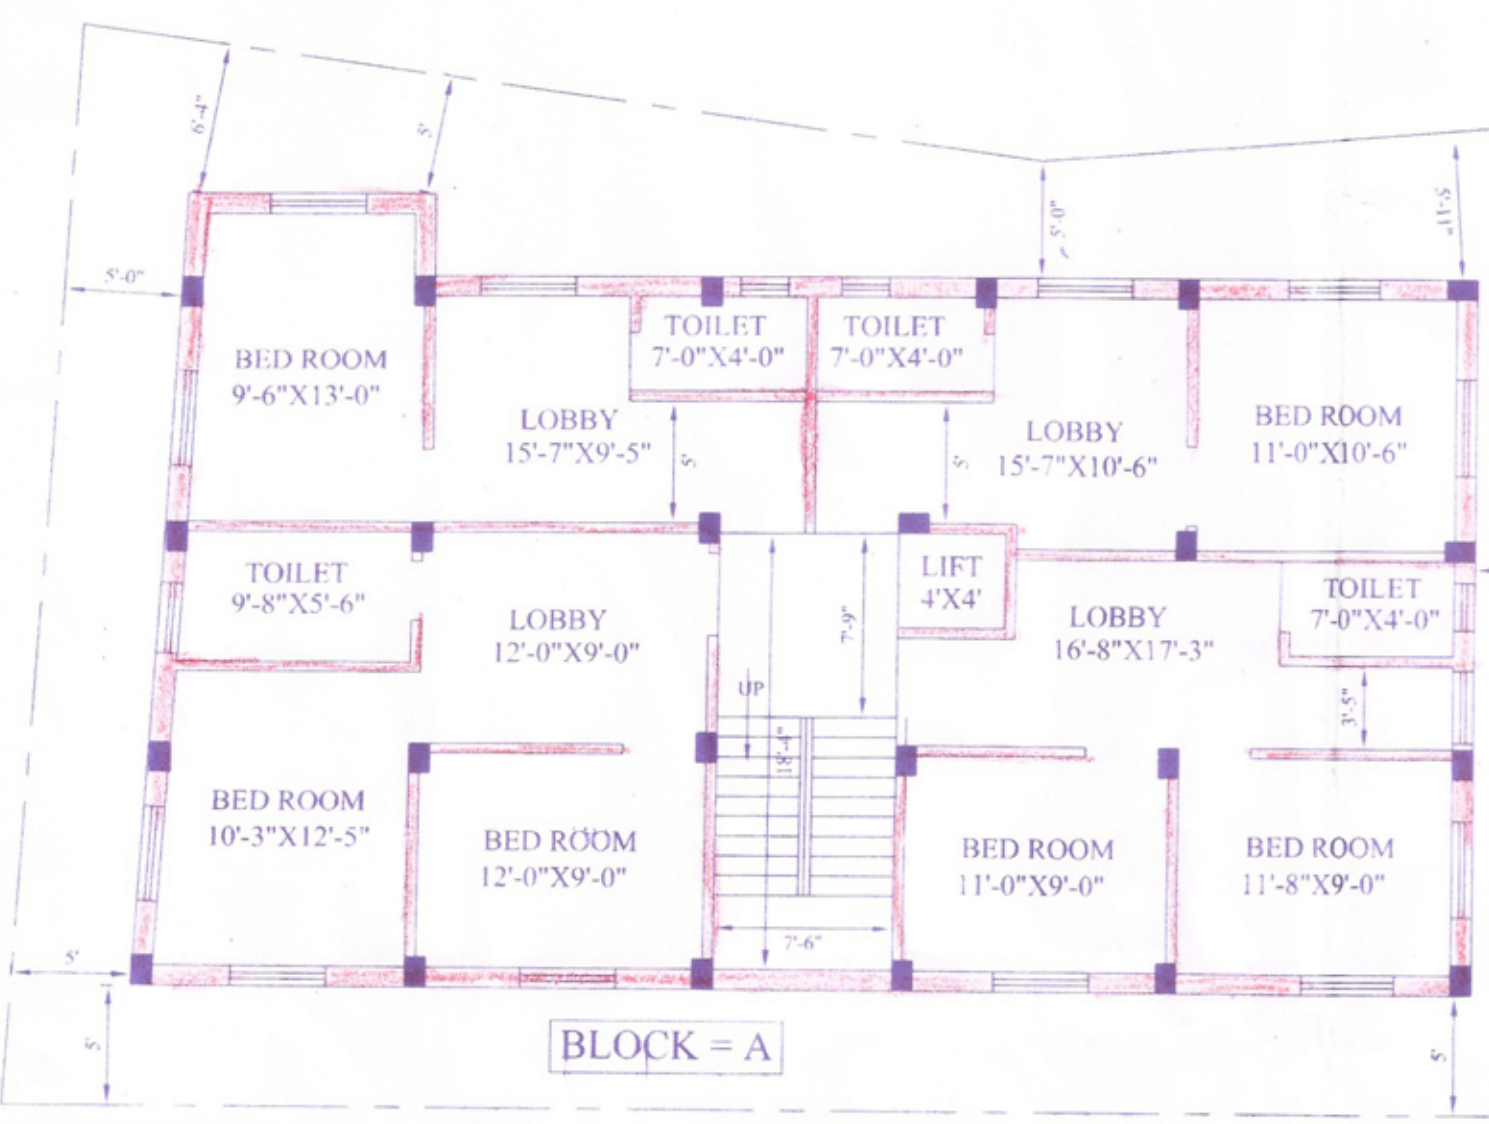



SITE PLAN
SCALE : 1"=16'-0"

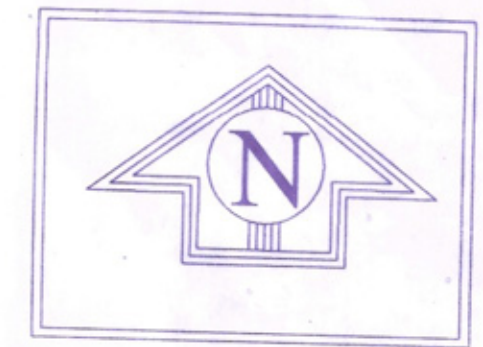


1ST. FLOOR TO 4TH, FLOOR PLAN

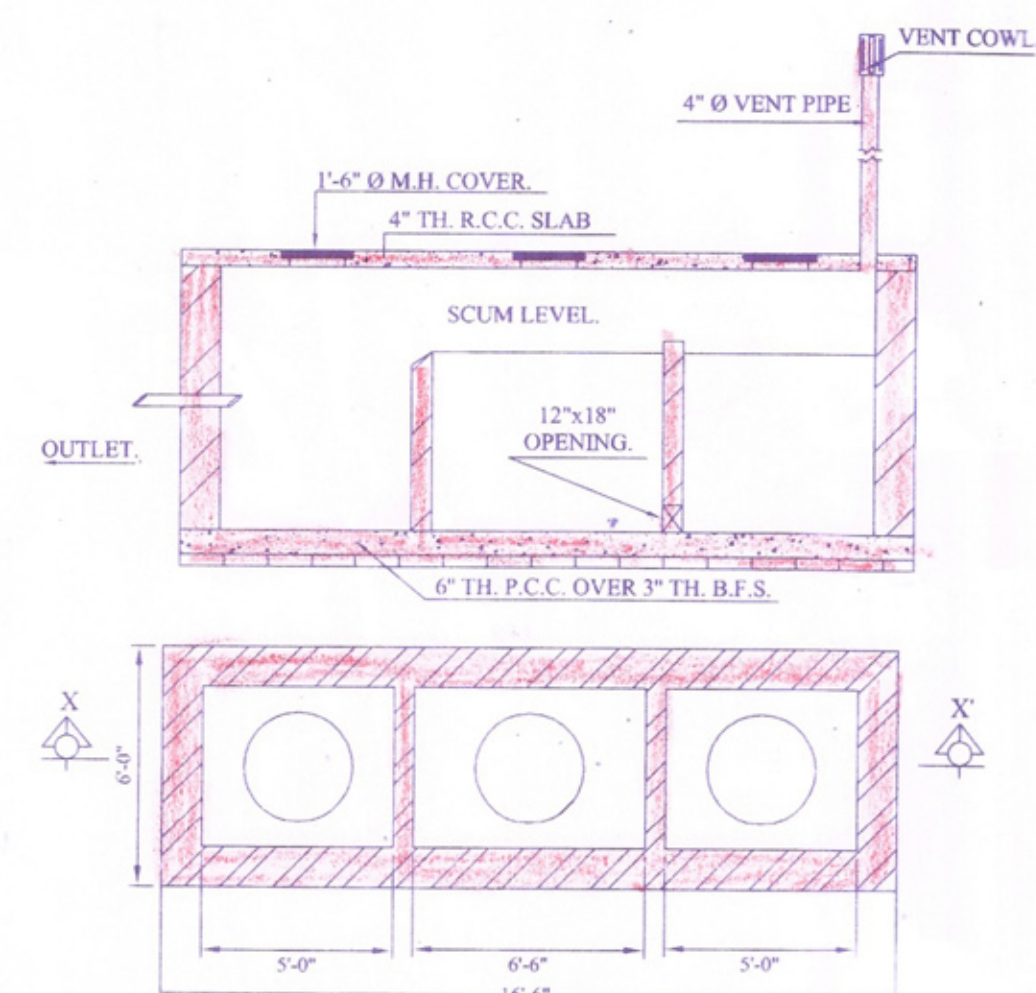

PLAN
DETAILS OF SEPTIC TANK
SCALE : 4'-00" = 1"

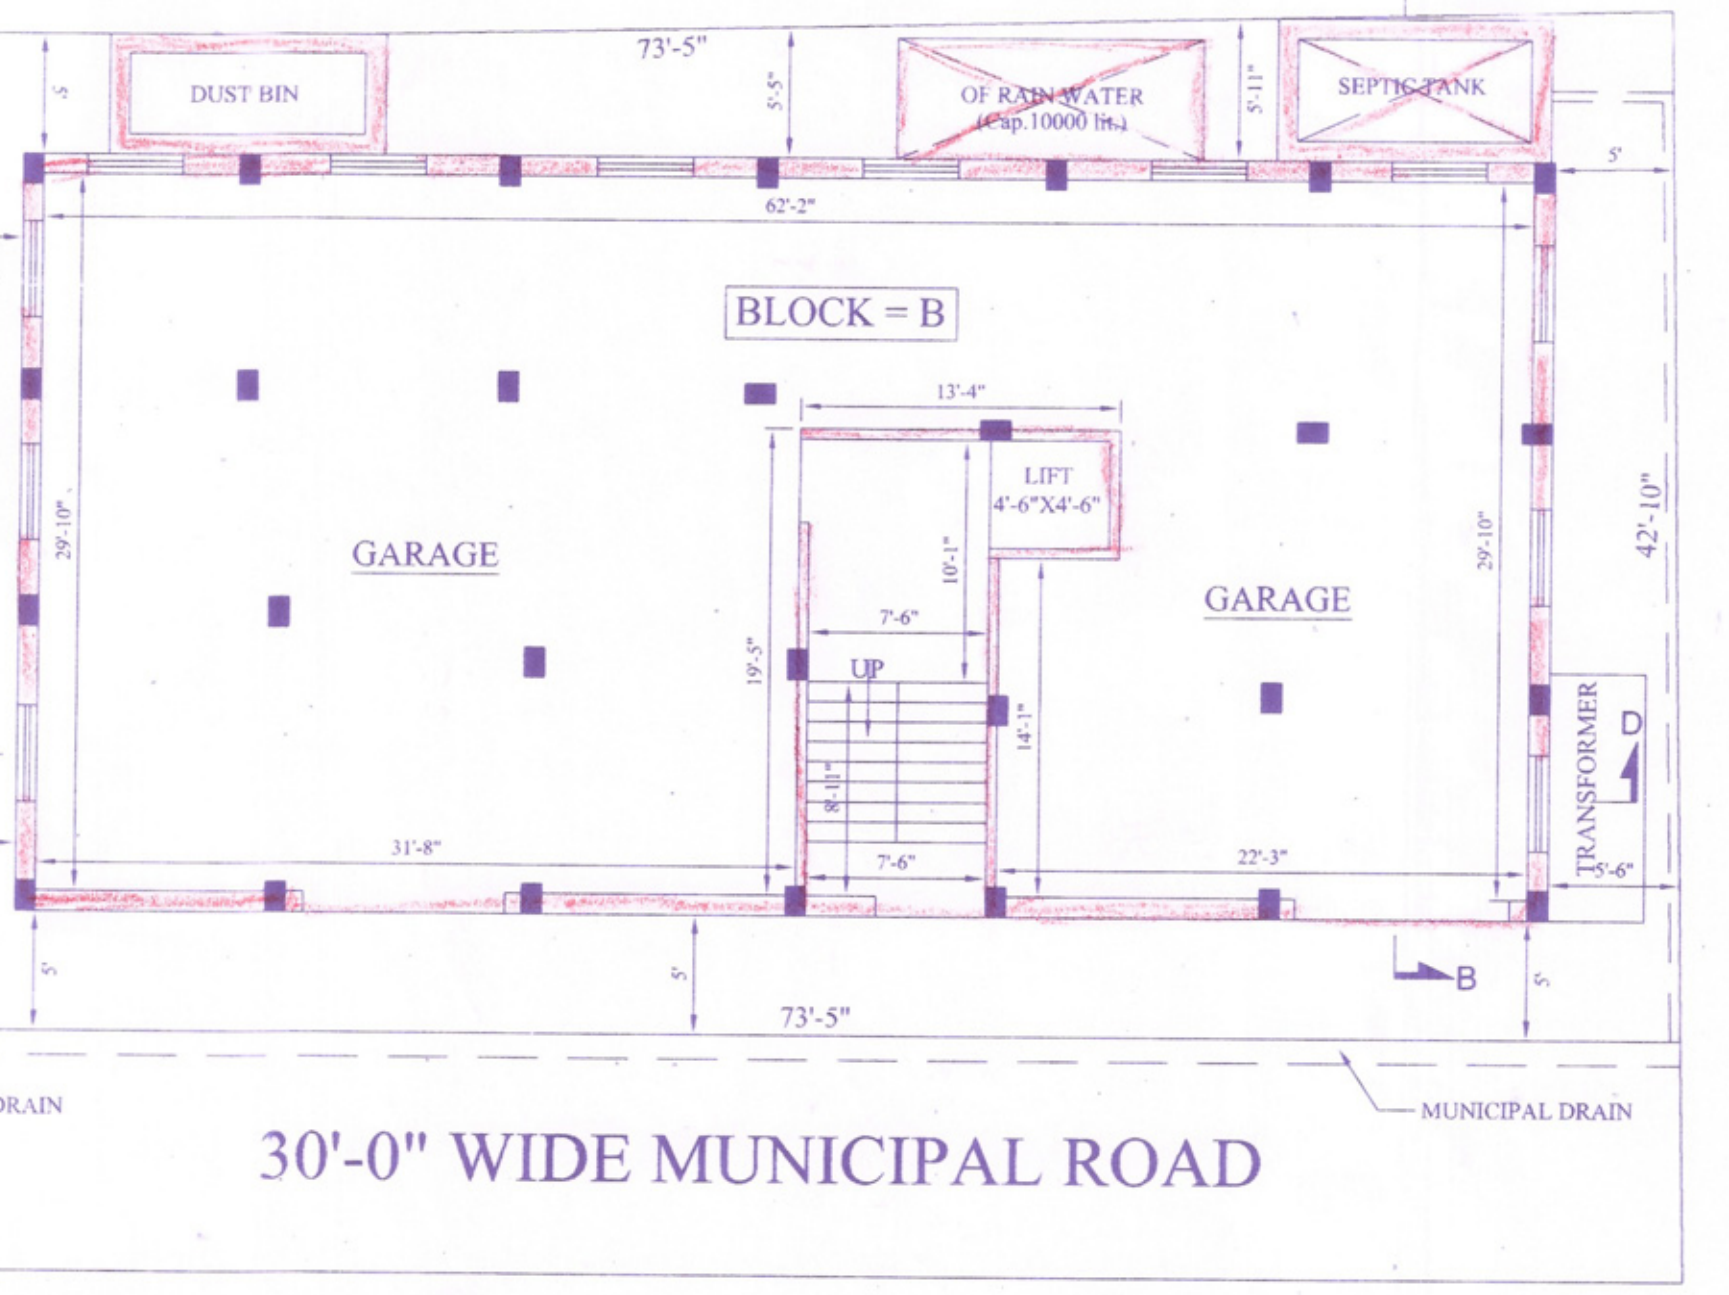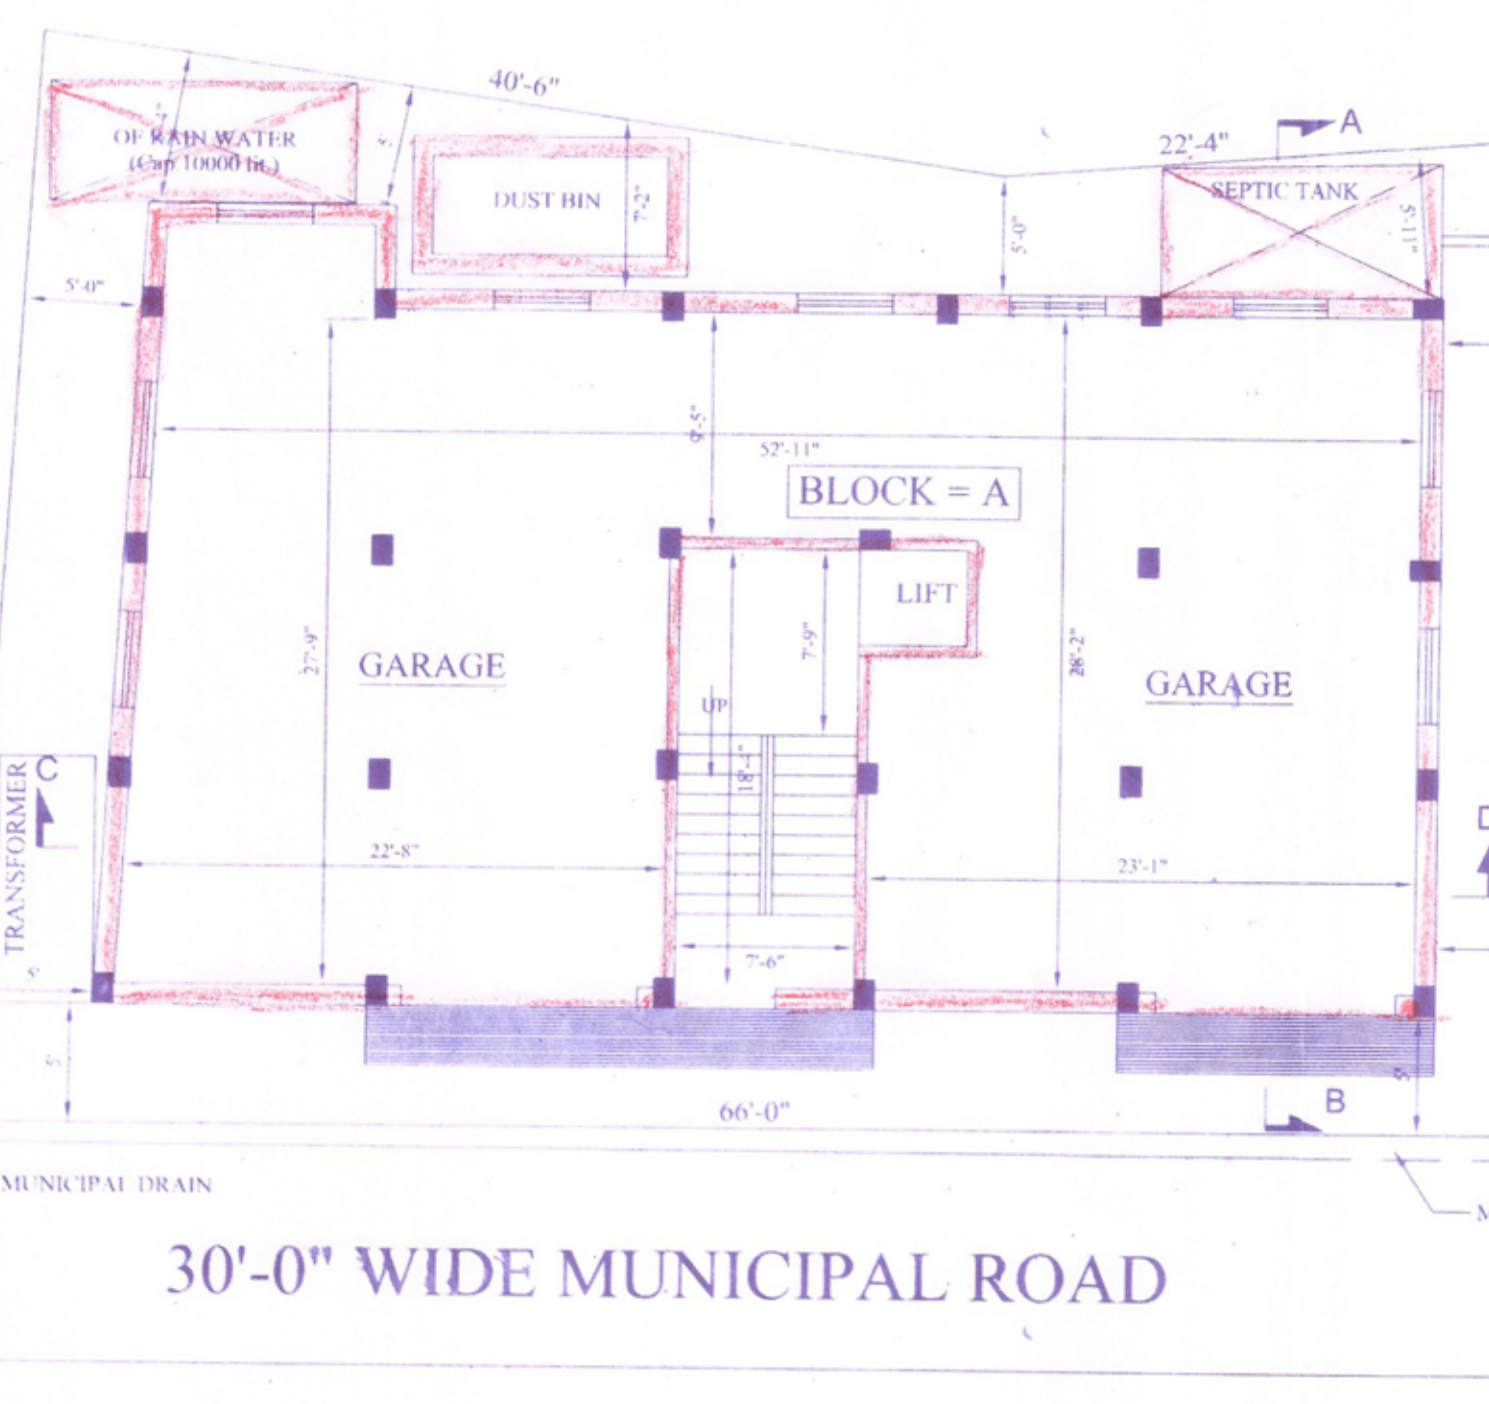

GROUND FLOOR PLAN

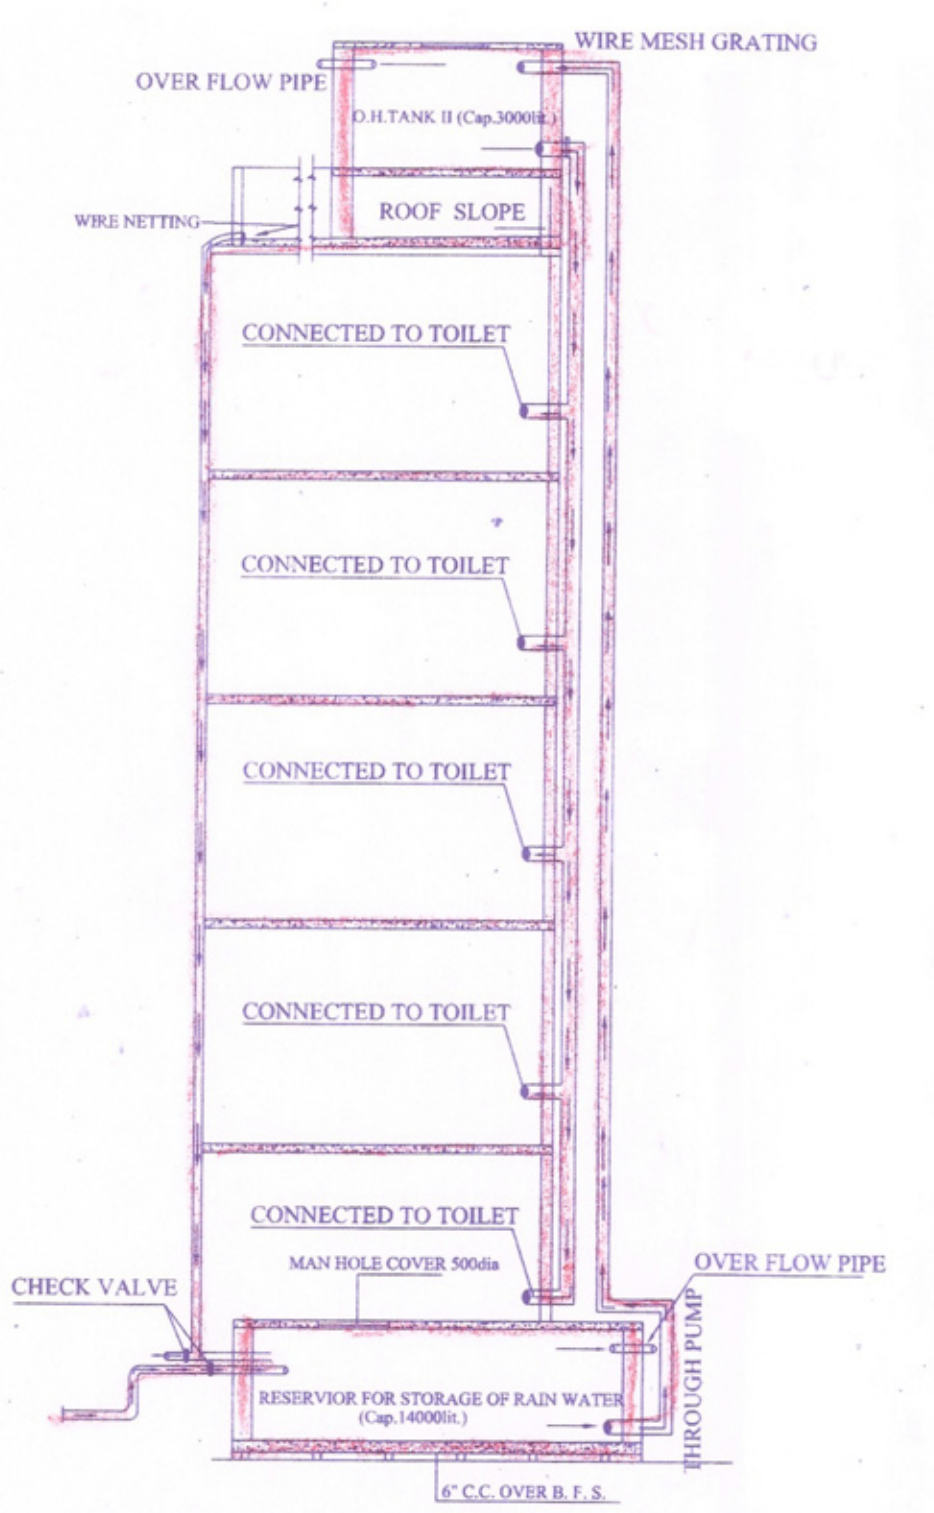

SECTIONAL ELEVATION OF PROPOSED
RAIN WATER HARVESTING FOR
RE - USE IN THE BUILDING

PLAN SHOWING THE PROPOSED (G + 4) STORIED BUILDING OF 1) SMT. ANJALI DAS, 2) SMT. ANITA DAS, 3) SRI AMIT DAS, 4) SRI KAMAL DAS, 5) SRI AMAR DAS, 6) SMT. SABITA DAS, W/O- SRI ARUN DAS, 7) SMT. KRISHNA NATH, W/O- SRI TARAK NATH, 8) SMT. NAMITA NATH, W/O- SRI PARTOSH NATH D/O - LT. RADHESHYAM NATH IN PART OF R. S. DAG NO- 1771/8024 & 1804, L. R. DAG NO- 12516 & 12515, UNDER KHATIAN NO.- 3433, L. R. KHATIAN NO- 8425 & 9877, IN MOUZA - RISHRA, J. L. NO.- 27 AT HOLDING NO - 3 / 220 / 6, B. C. ROY SARANI, 5TH. LANE, WARD NO- 16 WITHIN RISHRA MUNICIPALITY P. S.- RISHRA, DIST.- HOOGHLY.

SCALE:- 1 Inch = 8'-0", 4'-0" 2'-0"

REFERENCE:- **BLOCK = A**
TOTAL AREA OF LAND :- 04 KAT.-00 CH.-00 SFT. (MORE OR LESS)
PROPOSED GR. FLOOR COVD AREA :- 1596 SFT.
PROPOSED 1 ST. FLOOR COVD AREA :- 1596 SFT.
PROPOSED 2 ND. FLOOR COVD AREA :- 1596 SFT.
PROPOSED 3 RD. FLOOR COVD AREA :- 1596 SFT.
PROPOSED 4 TH. FLOOR COVD AREA :- 1596 SFT.
TOTAL COVD. AREA :- 7980 SFT. OR 741.63 M2
VOLUMN OF CONST.- 2108.25 m3
OPEN TO SKY:- 1284 SFT.

REFERENCE:- **BLOCK = B**
TOTAL AREA OF LAND :- 04 KAT.-00 CH.-00 SFT. (MORE OR LESS)
PROPOSED GR. FLOOR COVD AREA :- 2013 SFT.
PROPOSED 1 ST. FLOOR COVD AREA :- 2013 SFT.
PROPOSED 2 ND. FLOOR COVD AREA :- 2013 SFT.
PROPOSED 3 RD. FLOOR COVD AREA :- 2013 SFT.
PROPOSED 4 TH. FLOOR COVD AREA :- 2013 SFT.
TOTAL COVD. AREA :- 10065 SFT. OR 935.40 M2
VOLUMN OF CONST.- 2659 m3
OPEN TO SKY:- 867 SFT.

SPECIFICATION :-
GRADE OF CONC :- M-20
GRADE OF STEEL :- Fe-415
FLOORING :- I.P.S. 1:2:4
BRICK WORK (10", 5", 3") :- 4:1 CEMENT MORTAR.
PLASTER :- 6:1 CEMENT MORTAR FOR BOTH WALLS.
R. C. C. COLUMNS NOS:- 21
PROP. AND OTHERS DETAILS SHOWN IN PLAN.
STRUCTURAL ANALYSIS & BAR BENDING SCHDULE DETAILS HAS BEEN SHOWN IN ANOTHER

Note :- I do hereby undertake that no civil or criminal case is pending before any court of law at this premise. If any order / orders has been passed and found then I shall be fully responsible.

The above statements are true to the best of my knowledge.

Sabita Das
Namita Nath
Anit Das
Anita Das
Amar Das

SIGN. OF OWNERS

SATYAJIT PODDAR
B.TECH.(E),A.M.I.E.(I)
Civil & Structural Engineer
Chartered Engineer (I) & Valuer
A11 1755385

DRAWN BY:-

SIGN. OF OWNERS

SHEET NO.- 1

Ref. No. B-163/2019-2020

PLAN SANCTIONED FOR THREE YEARS

A report to be given to this office within a month from the date of completion of the structure as per sanctioned plan.

25/11/2019

Sub-Assistant Engineer
Rishra Municipality
Rishra, Hooghly

Chairman
Rishra Municipality
Rishra, Hooghly

SUBJECT TO THE FOLLOWING CONDITIONS

1. Only the Municipal water connection will be given to the concerned premises. In addition to this the applicant will have to make his own arrangement for supply of water for the occupation of the premises after taking necessary written permission from the Water Works Department of this Municipality.
2. Necessary information should be furnished to the Municipal Authority regarding completion of construction up to roof of each floor and after total completion of the building.
3. Construction should be made under supervision of a qualified Civil/Structural Degree/Diploma Engineer/L.B.S. who will confirm in writing to the Municipality of having undertaken the responsibility of supervision of the proposed construction and submit at various stages during the construction.
4. Necessary house fire fighting equipments to be provided by the Owner of the building in the concerned premises.
5. In any circumstances, the building materials would not be allowed to keep on the Municipal Road/Road flank during the construction.